



- NOTE:**
- DO NOT DEPLOY IN A MANNER THAT SILT FENCES WILL ACT AS A DAM ACROSS PERMANENT FLOWING WATERCOURSES. SILT FENCES ARE TO BE USED AT UPLAND LOCATIONS AND TURBIDITY BARRIERS USED AT PERMANENT BODIES OF WATER.
 - SPACING FOR TYPE III FENCE TO BE IN ACCORDANCE WITH CHART I ABOVE AND DITCH INSTALLATIONS AT DRAINAGE STRUCTURES.
 - SILT FENCE TO BE PAID FOR UNDER THE CONTRACT UNIT PRICE FOR STAKED SILT FENCE (LF).


3
5.0
TYPE III SILT FENCE
NOT TO SCALE

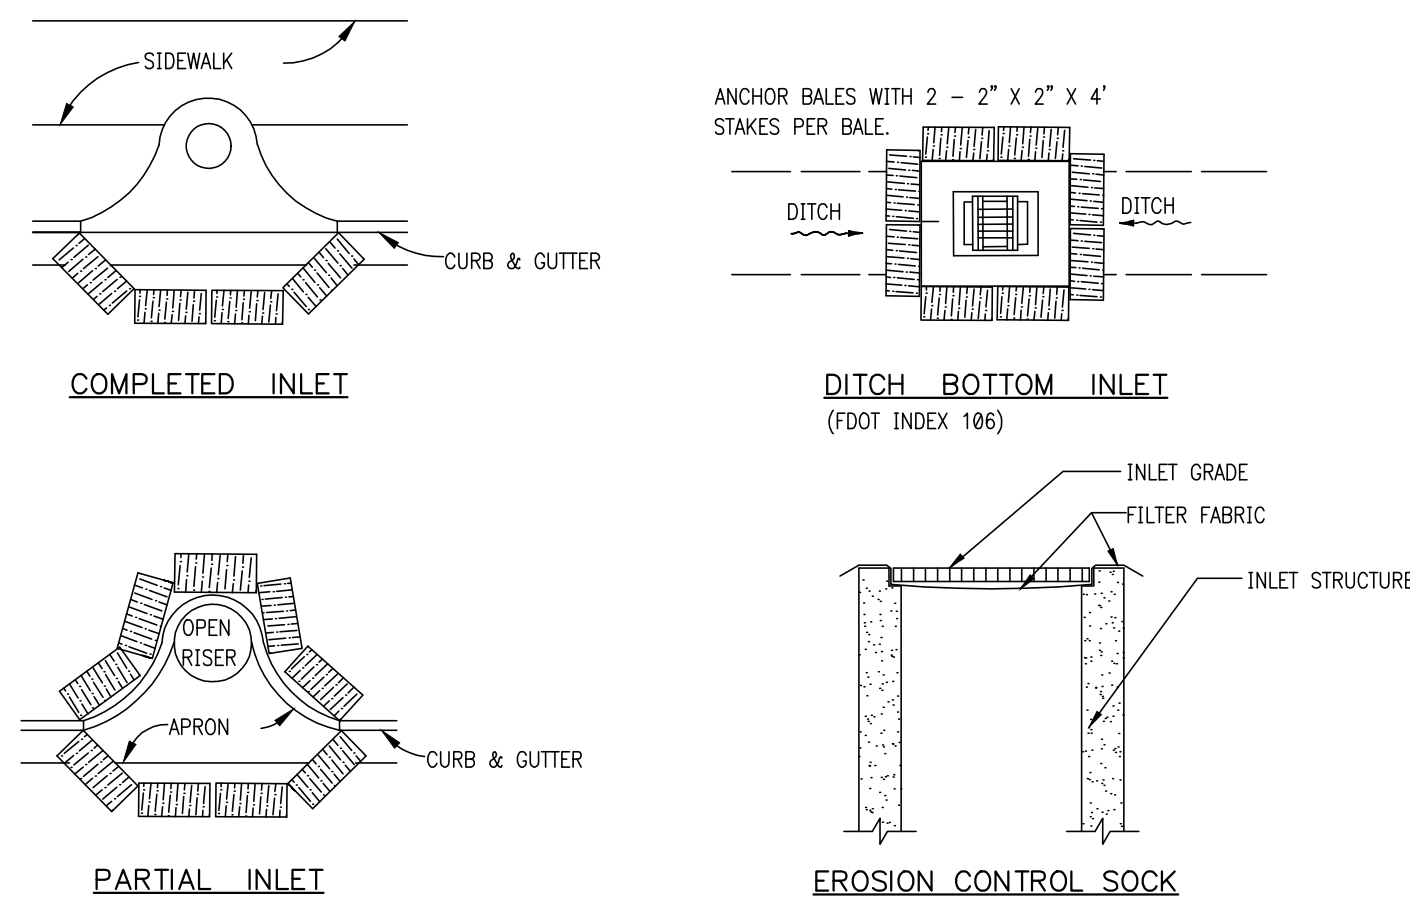


4
5.0
PROTECTION AROUND INLETS OR SIMILAR STRUCTURES
NOT TO SCALE

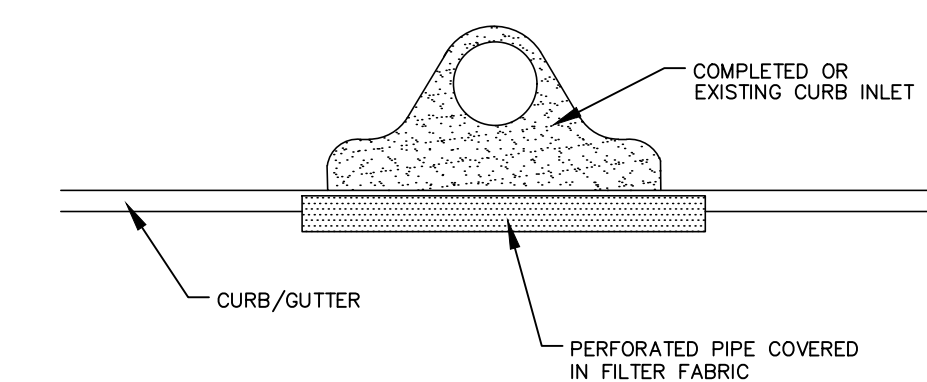

5
5.0
POLLUTION PREVENTION BARRIER FOR STORM CURB INLETS
NOT TO SCALE

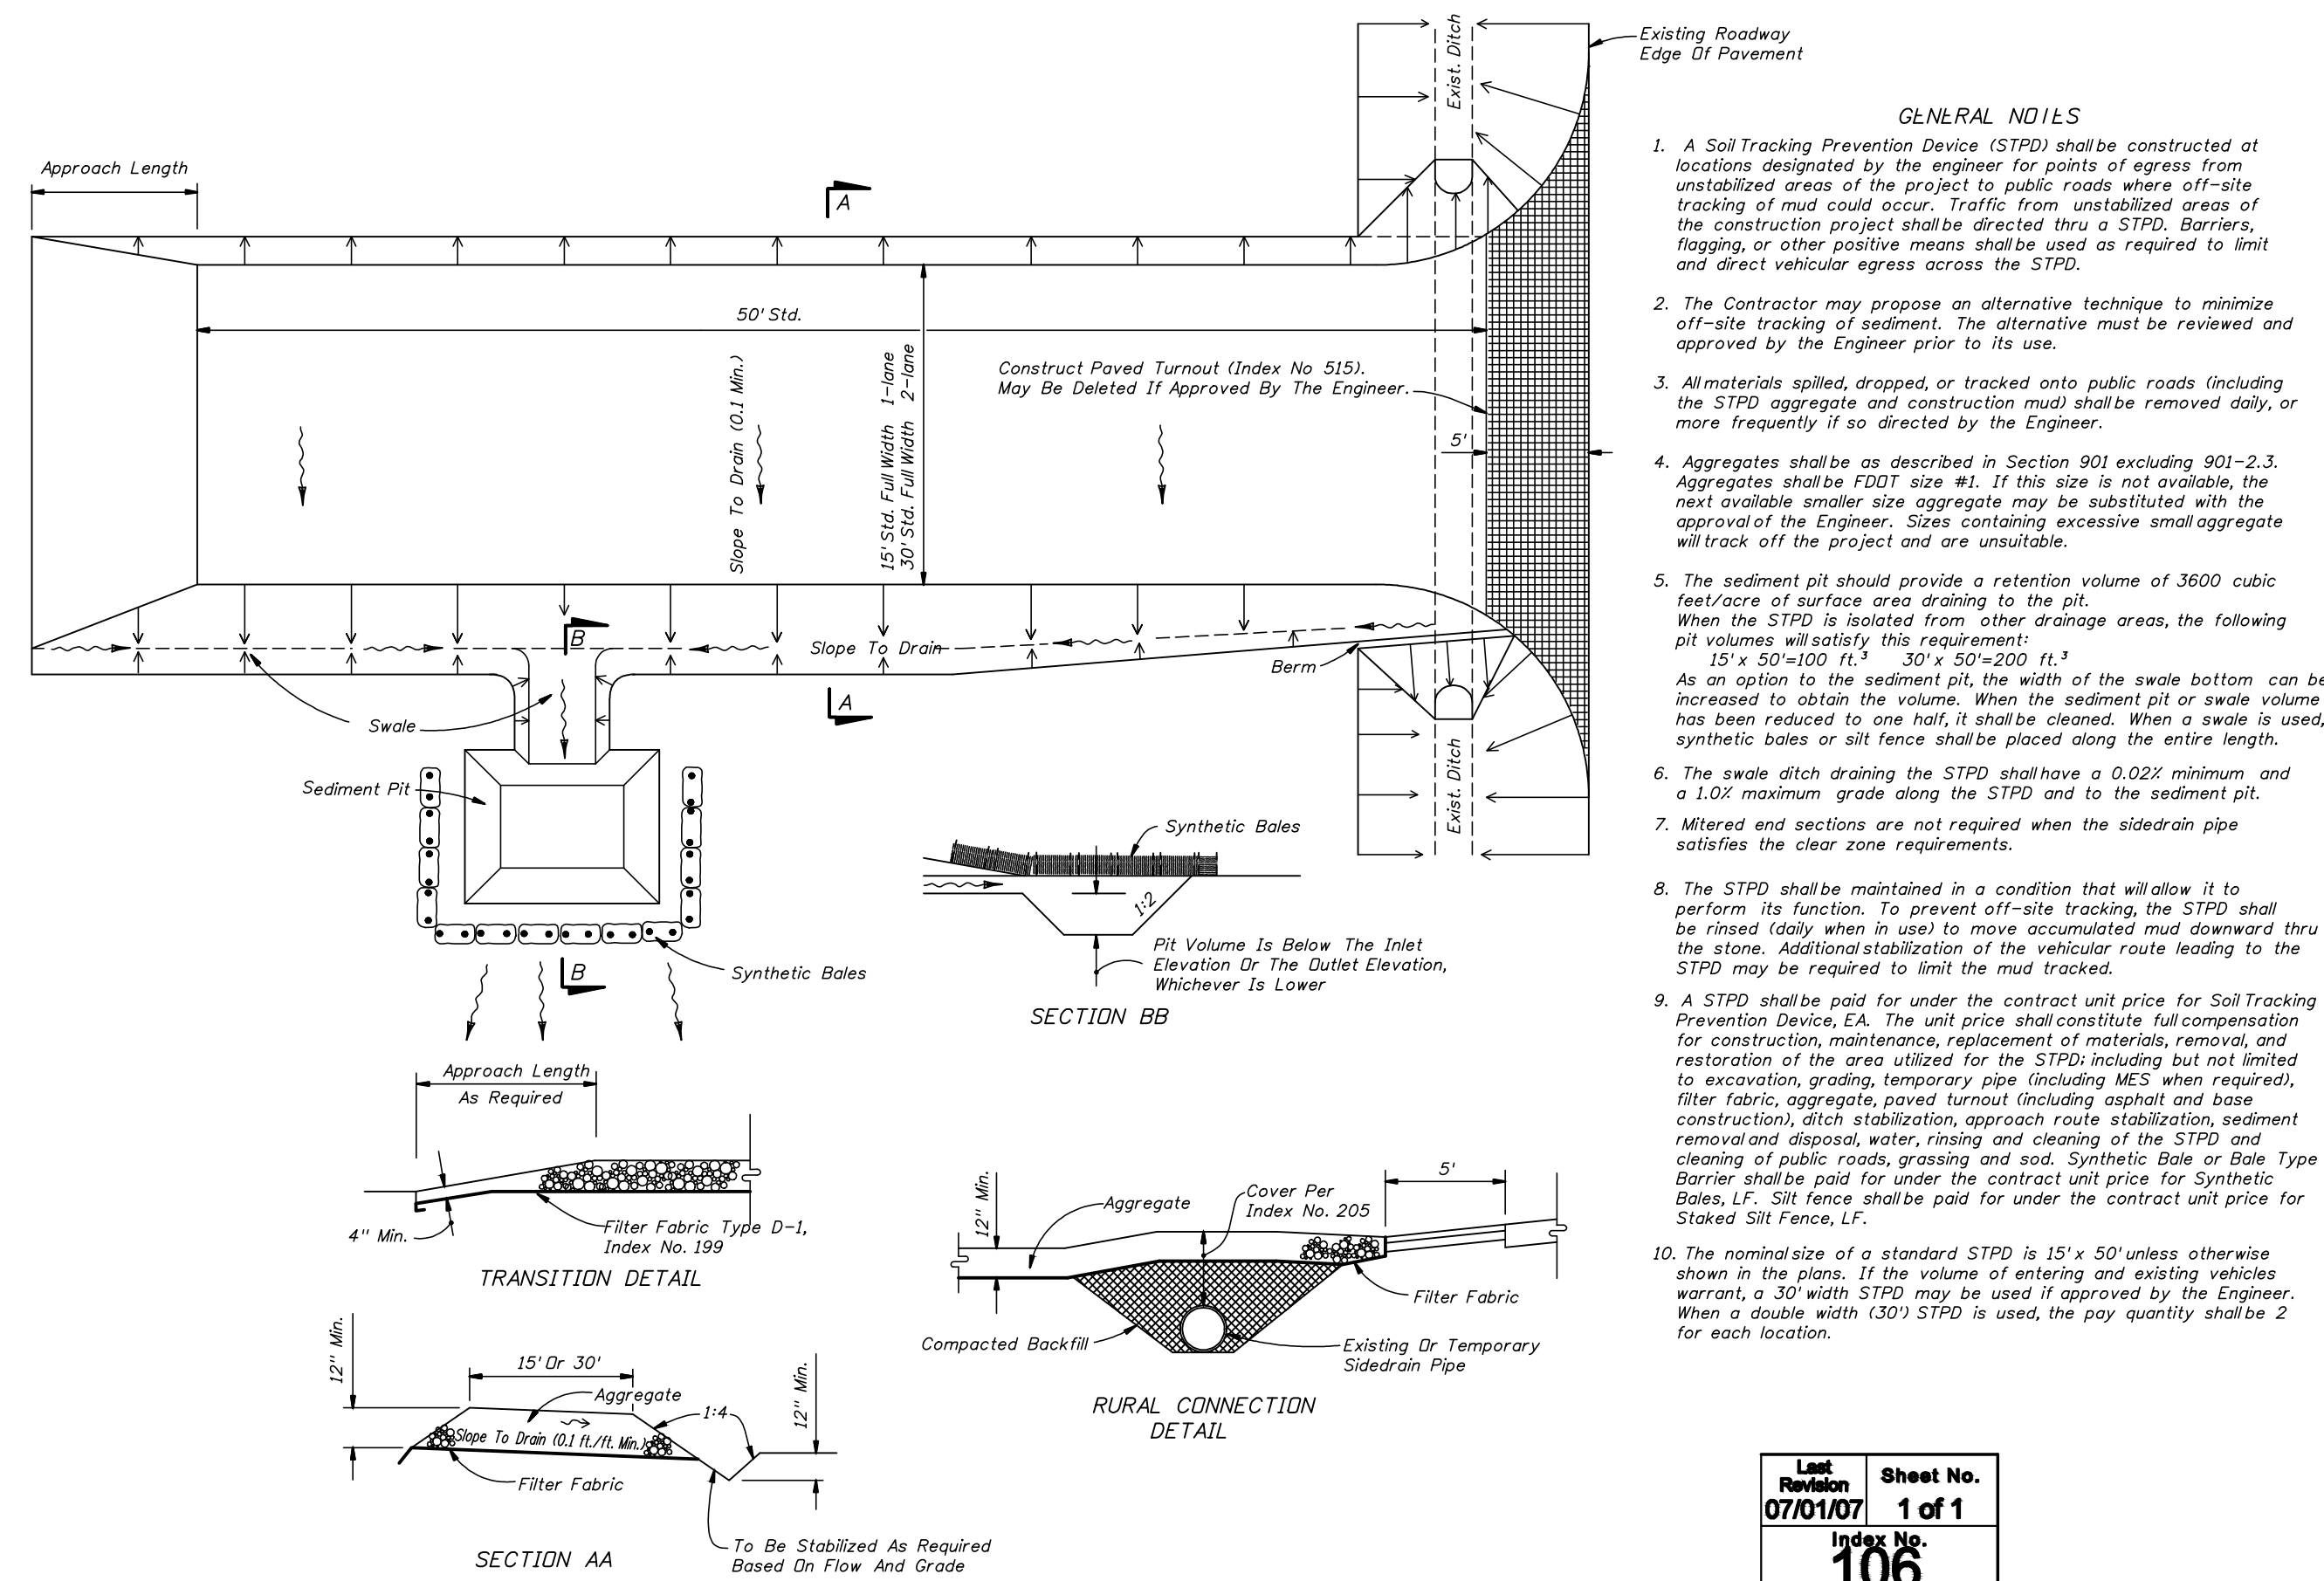


2
5.0
SOIL TRACKING PREVENTION DEVICE - TYPE A
NOT TO SCALE

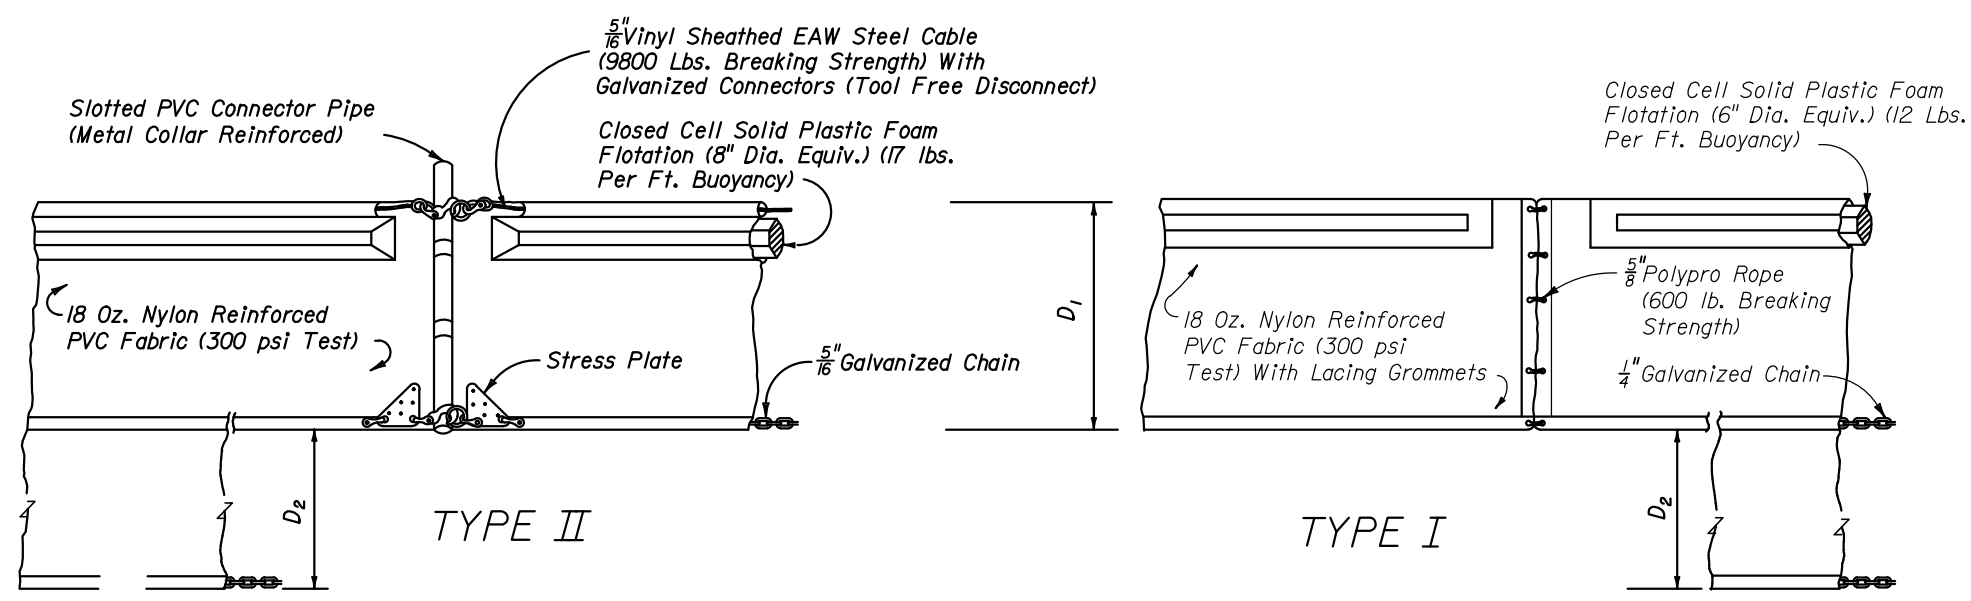

NOTICE: COMPONENTS OF TYPES I AND II MAY BE SIMILAR OR IDENTICAL TO PROPRIETARY DESIGNS. ANY INFRINGEMENT ON THE PROPRIETARY RIGHTS OF THE DESIGNER SHALL BE THE SOLE RESPONSIBILITY OF THE USER. SUBSTITUTIONS FOR TYPES I AND II SHALL BE AS APPROVED BY THE ENGINEER.


FLOATING TURBIDITY BARRIERS

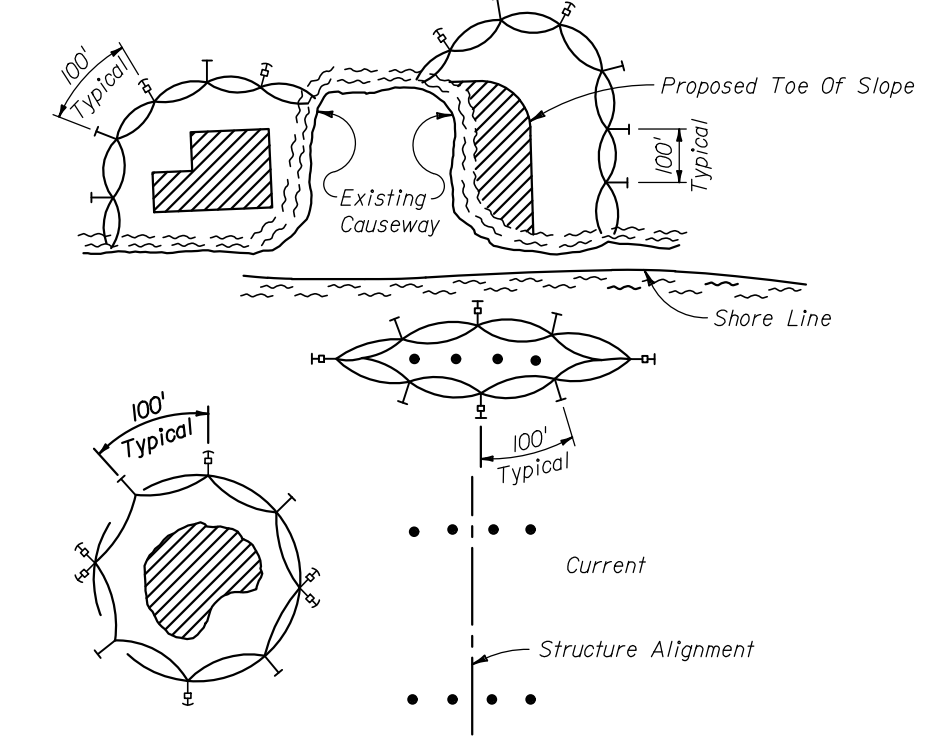

TURBIDITY BARRIER APPLICATIONS

1
5.0
TURBIDITY BARRIERS
NOT TO SCALE

STAKED TURBIDITY BARRIER

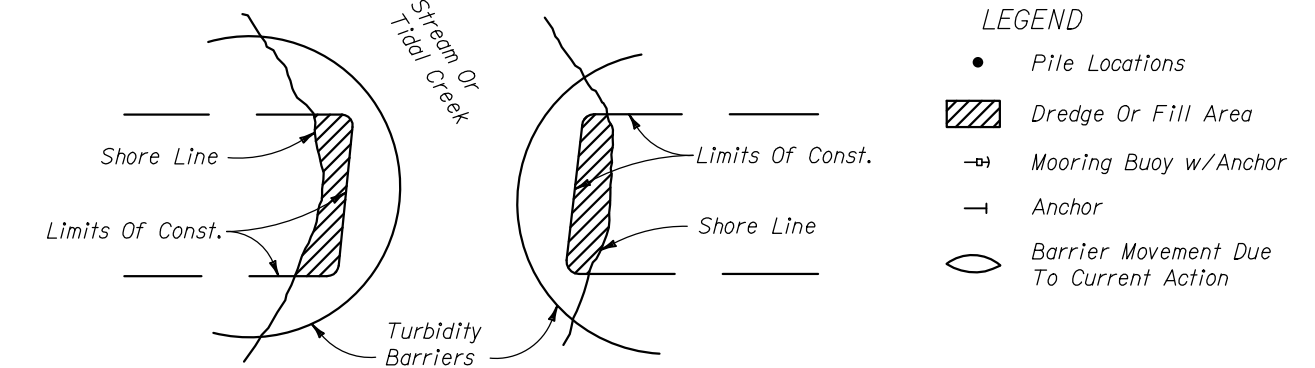

NOTE: TURBIDITY BARRIERS FOR FLOWING STREAMS AND TIDAL CREEKS MAY BE EITHER FLOATING, OR STAKED TYPES OR ANY COMBINATIONS OF TYPES THAT WILL SUIT SITE CONDITIONS AND MEET EROSION CONTROL AND WATER QUALITY REQUIREMENTS. THE BARRIER TYPES WILL BE AT THE CONTRACTOR'S OPTION UNLESS OTHERWISE SPECIFIED IN THE PLANS, HOWEVER PAYMENT WILL BE UNDER THE PAY ITEM(S) ESTABLISHED IN THE PLANS FOR FLOATING TURBIDITY BARRIER AND/OR STAKED TURBIDITY BARRIER. POSTS IN STAKED TURBIDITY BARRIERS TO BE INSTALLED IN VERTICAL POSITION UNLESS OTHERWISE DIRECTED BY THE ENGINEER.

BY	TV
REVISIONS	MWK
DATE	JKS
REV PER	JKS
REV PER	JKS
REV PER	JKS
REV PER	JKS
REV PER	JKS
REV PER	JKS
REV PER	JKS
REV PER	JKS

EVANS ENGINEERING, INC.
CERTIFICATE OF AUTHORIZATION NO. 6726

EVANS ENGINEERING, INC.
LAND PLANNING PERMITTING SERVICES
719 IRMA AVENUE
ORLANDO, FLORIDA 32803
(407) 875-1515
WWW.EVANSENGINEERING.COM
FLORIDA P.E. NO. 46586
DATE:

EVANS ENGINEERING, INC.
LAND PLANNING PERMITTING SERVICES
719 IRMA AVENUE
ORLANDO, FLORIDA 32803
(407) 875-1515
WWW.EVANSENGINEERING.COM
FLORIDA P.E. NO. 46586
CERTIFICATE OF AUTHORIZATION NO. 00006785

FESTIVAL PHASE 2 RESIDENTIAL FOR MINTO COMMUNITIES
POLK COUNTY
FLORIDA

FINAL CONSTRUCTION PLANS
STORMWATER POLLUTION PREVENTION DETAILS

DRAWN: MWK
CHECKED: DLE
DATE: MAY 2015
SCALE: N.T.S.
JOB NO: 28102
SHEET #:

5.0